






LECTURE THEATRE CHAIR IMAGES

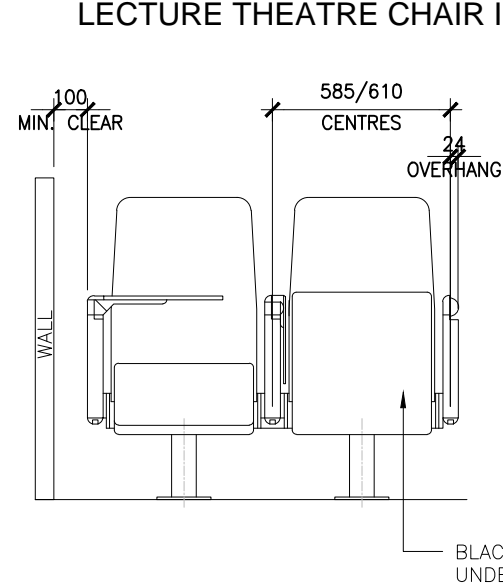


FRONT ELEVATION

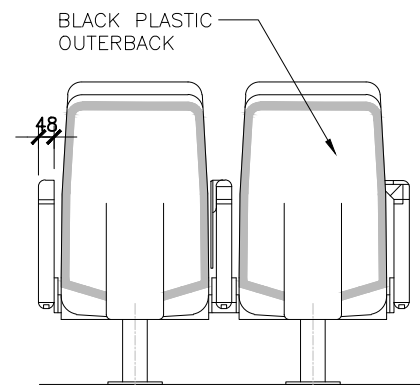

REAR ELEVATION

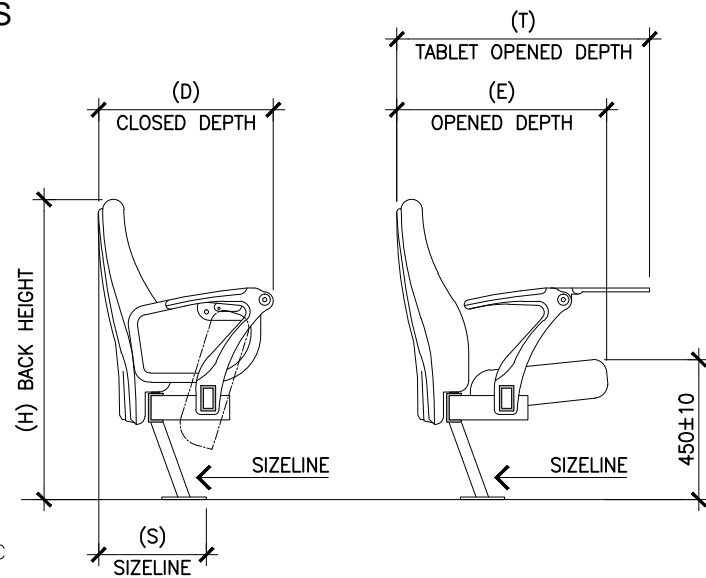

SIDE ELEVATION

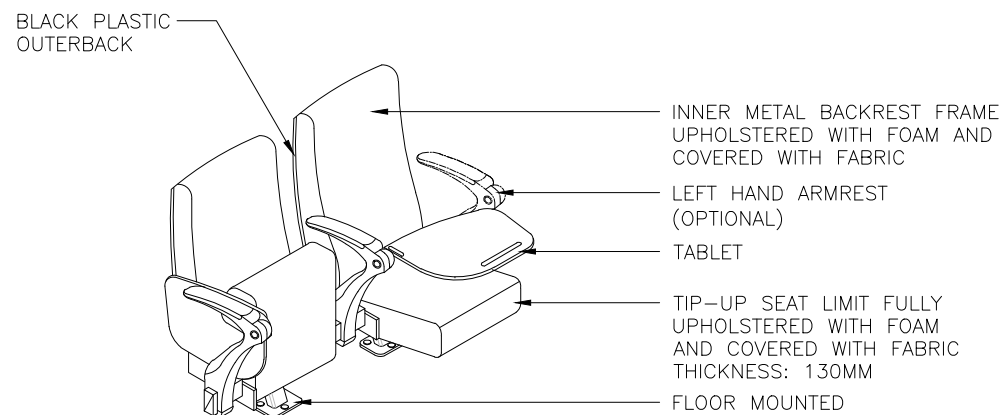

ISOMETRY

SPECIFICATIONS:

BACKREST

- FULLY UPHOLSTERED BACKREST WITH REAR FACE OF THE BACKREST IN PLASTIC OUTERBACK.
- THE INNER STRUCTURE IS MADE OF 19x 19x 1.6mm THKS. HOLLOW SECTION, UPHOLSTERED WITH HR POLYURETHANE FOAM DENSITY 45 kg/m³ AND UPHOLSTERED WITH FABRIC COVERS.

SEAT

- FULLY UPHOLSTERED SEAT WITH PADDED COVER.
- INNER STRUCTURE MADE OF Ø21mm THK. 2mm TUBULAR STEEL FRAME, INTEGRATED WITH GRID FOUNDATION IN HR FOAMS WITH A DENSITY OF 60 kg/m³.
- TIP-UP SEAT WITH COUNTERWEIGHT SYSTEMS AND BEING LIFT-UP BY MEANS OF GRAVITY. TOTALLY SILENT AND MAINTENANCE FREE.

LEG / BEAM

- RECTANGULAR HOLLOW SECTION OF 76 x 38mm STRCUTURAL STEEL BEAM.
- BEAM END PROTECTED WITH NYLON CAPPING.
- FIXED FLOOR MOUNTED IN EVERY 3 SEATS.

TABLET

- RUBBER WRIMATIC ARM TABLET
- HEAVY DUTY DIE-CAST ALUMINUM ALLOY FINISHED IN OVER BAKED EPOXY POWDER COATING TO 60 MICRON.
- THE ARM CONSISTS OF A COMPLEX SWIVEL JOINT IN PRECISELY FABRICATED STAINLESS STEEL WITH POLISH FINISH.
- HOUSED WITHIN THE SWIVEL JOINT IS A MAINTENANCE-FREE BEARING FOR LONG TERM OPERATION CYCLES.
- STATIC BEARING LOAD > 250 kgs - DYNAMIC BEARING LOAD > 40 kgs.
- SWIVEL PLATE SUPPORTING THE WRITING BOARD MADE OF HEAVY-DUTY PLATE DIE-CAST ALUMINUM ALLOY IN EPOXY POWDER COATING.
- THE ARM SHALL BE CLAMPED TO THE HORIZONTAL BEAM BY MEANS OF A HEAVY-DUTY PLATE (DIE-CAST ALUMINUM ALLOY), WITH USE OF TWO ALLEN CAP SCREWS.
- WRITING BOARD MADE OF 10mm THICK INJECTION MOULDED ABS.
- SIZE 300mm BY 425mm
- THE WRITING BOARD IS LARGE ENOUGH TO ACCOMODATE A3 SIZE PAPER, LAPTOP AND ITS LEFT-HAND FRIENDLY DESIGN SUITS ALSO THE MINORITY.

METAL FINISHING

- ALL METAL PARTS EXPOSED SHALL BE STRIPPED AND CLEANED WITH IRON PHOSPHATE, HOT WATER RINSED AND THEN CHROMIC ACID RINSED.
- ALL METAL PARTS ARE COATED WITH AN EPOXY FINISH OF AT LEAST 60 MICRONS FOR INDOOR USE.
- CONFORMITY WITH BS-6496 HARDNESS TEST.

FABRIC

- SELECTED GRADE A FABRIC WITH FLAMMABILITY COMPLIANCE OF CLASS O.

MISCELLANEOUS

- PVC SEAT NUMBERING.
- ROW LETTERING ON END CAP.
- SEAT NUMBERING ON WRIMATIC ARM.
- FLAMMABILITY COMPLIANCE WITH BS 5852 : 2006 SECTION 3 IGNITION SOURCE 5.



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Job Title	Senior Vice President
PROPOSED KDU PENANG @ BATU KAWAN, PENANG MALAYSIA	TAN PHENG CHEE
Drawing Title	Vice President
LECTURE THEATRE FLIP-UP TABLE WITH TABLET DETAIL	PATRICK TAN
BLOCK D 1ST - 2ND FLOOR	Principal Architectural Associate
	-
	Architectural Associate
	-
	Principal Interior Designer
	BETH SONCUYA

TENDER DRAWING

Drawn By	TEAM		Date: JULY 16
Checked By	BETH		Date: JULY 16
Project Code :	Drawing No. :	REV.	Scale : NTS
P5679	ID-FT-D-304-24	-	CAD Ref.